


GENERAL NOTES

- REFER TO SHEET ZSPTX-G-0002 FOR GENERAL NOTES, SYMBOLS, AND ABBREVIATIONS.
- 2. VERIFY IN FIELD ALL COLUMNS DIMENSIONS. COLUMN ENCLOSURES TO BE HELD TIGHT AGAINST FIRE- PROOFED COLUMNS.
- 3. ALL EXPOSED/VISIBLE EXISTING CABLE RELATED TO ANY AND ALL SERVICES NOT LIMITED TO MECHANICAL, ELECTRICAL, DATA, SECURITY, FIRE ALARM, PLUMBING TO BE NEATLY ORGANIZED BY
- 4. CONTRACTOR REQUIRES ARCHITECTS APPROVAL AND SIGN OFF ON MOCK UP AT ANY AN ALL AREAS WHERE THIS CONDITION EXISTS.
- 5. CONTRACTOR IS RESPONSIBLE FOR REPAIRING ANY DAMAGE TO RATED PARTITIONS AS A RESULT OF THIS WORK. THE INTEGRITY OF ALL RATED PARTITIONS IS TO BE MAINTAINED DURING CONSTRUCTION.
- 6. ALL DOORS TO BE OFFSET 6" FROM ADJACENT PARTITION.
- 7. LOW WALL AIR RETURNS SIZES AND LOCATIONS TO BE COORDINATED WITH MECHANICAL DRAWINGS.
- 8. PROVIDE EQUIPMENT PAD IN UTILITY ROOMS.
- 9. COORDINATE PAD SIZES AND LOCATIONS WITH ELECTRICAL AND PLUMBING MECHANICAL AND PROCESS DRAWINGS FOR REQUIRED EQUIPMENT. PAD SIZES AND LOCATIONS TO BE DEPENDENT ON FINAL SELECTION OF EQUIPMENT.







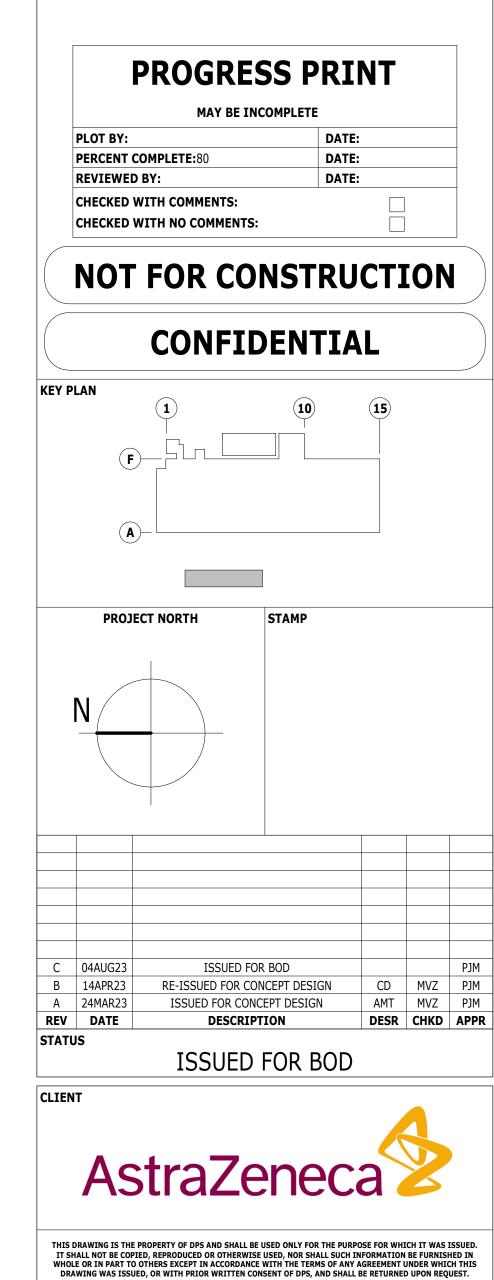

1/8" = 1'-0"

ASTRAZENECA - TANK FARM


CLIENT NO.

CONTAINMENT PIT


DRAWING NO.

ZSPTX-AE-0101

CONSTRUCTION FLOOR PLAN

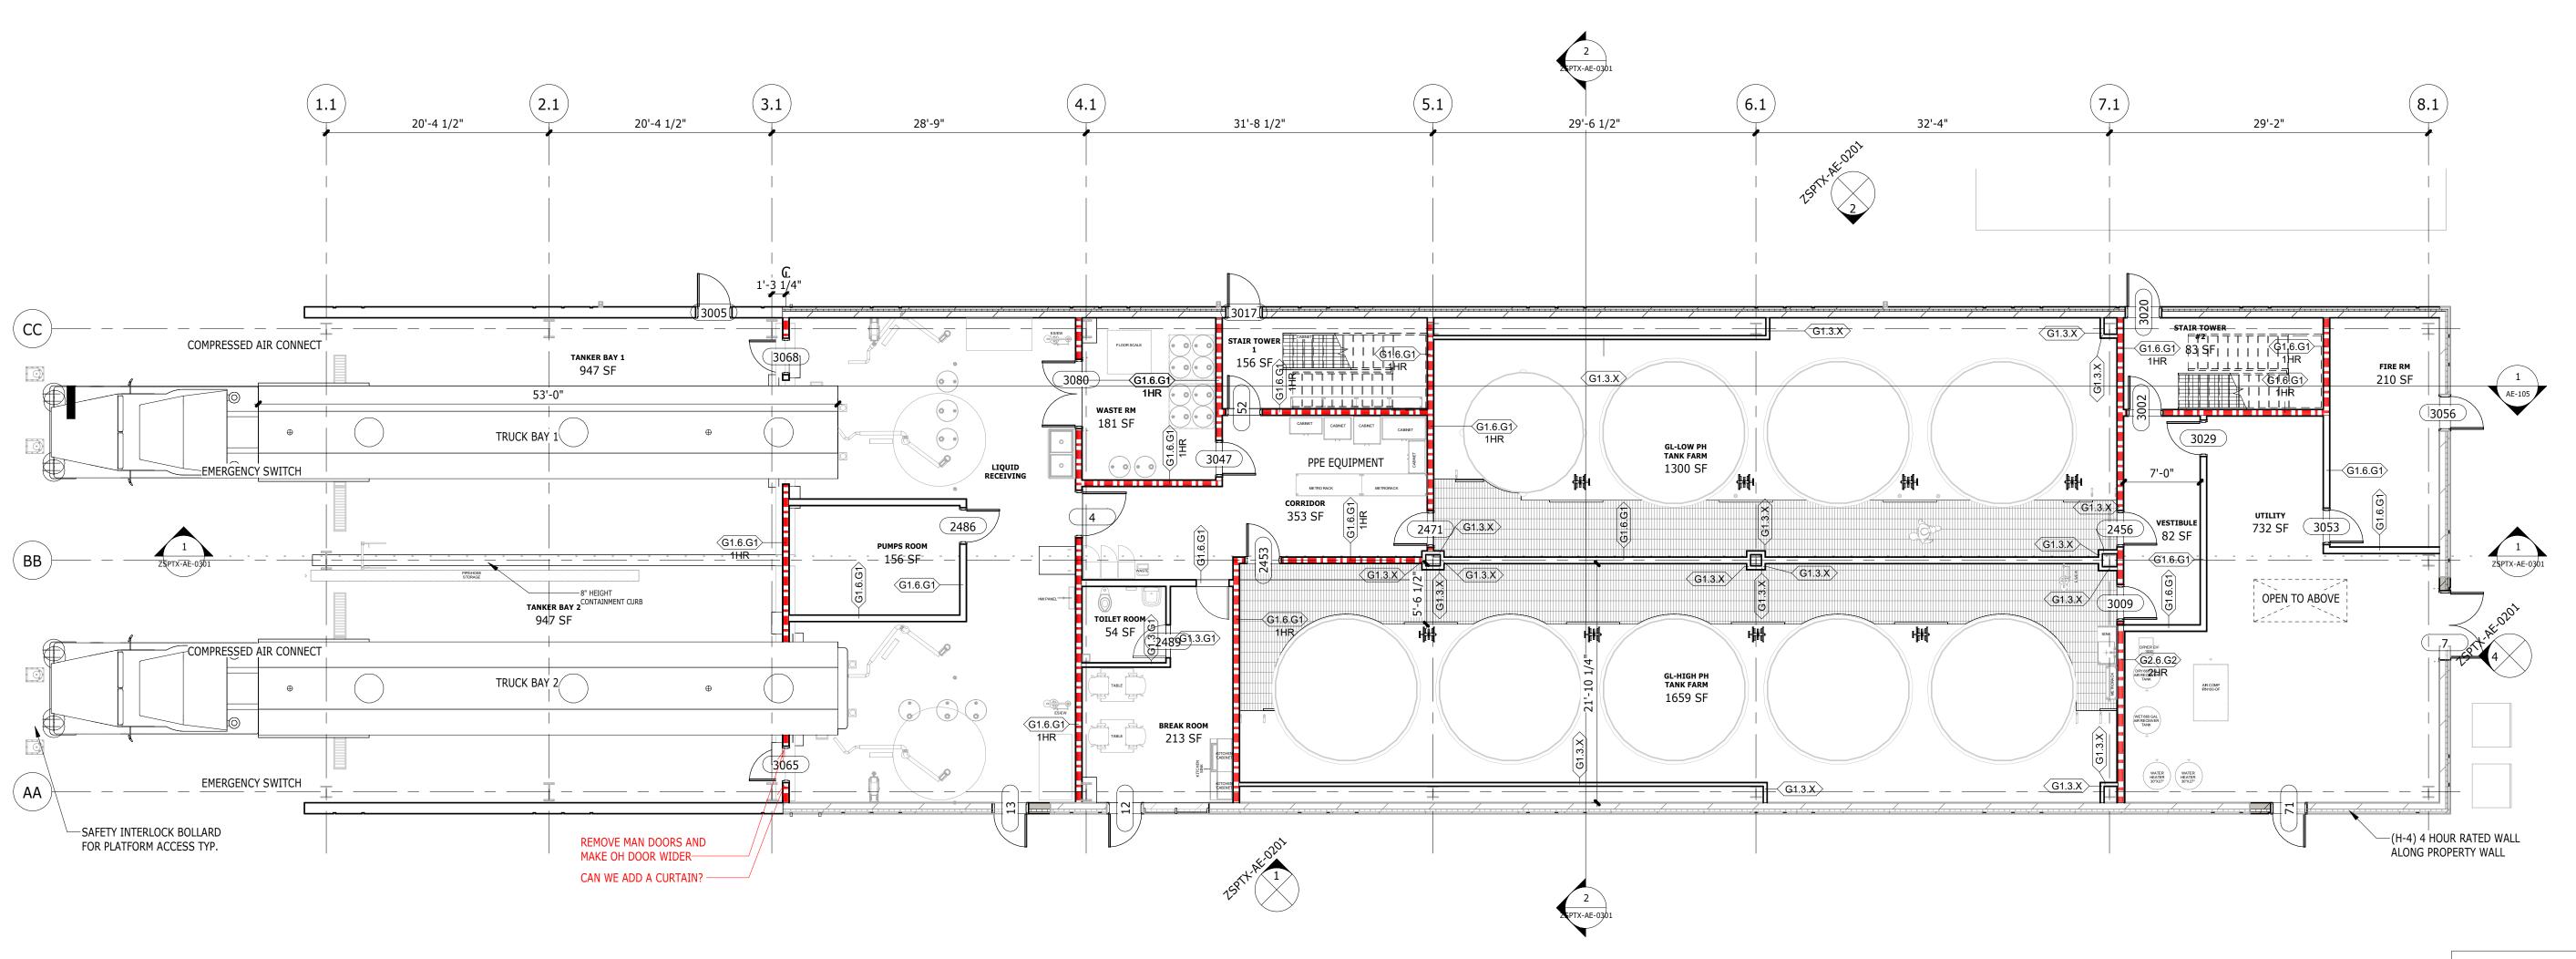

1 LEVEL 01 - CONSTRUCTION FLOOR PLAN
SCALE: 1/8" = 1'-0"

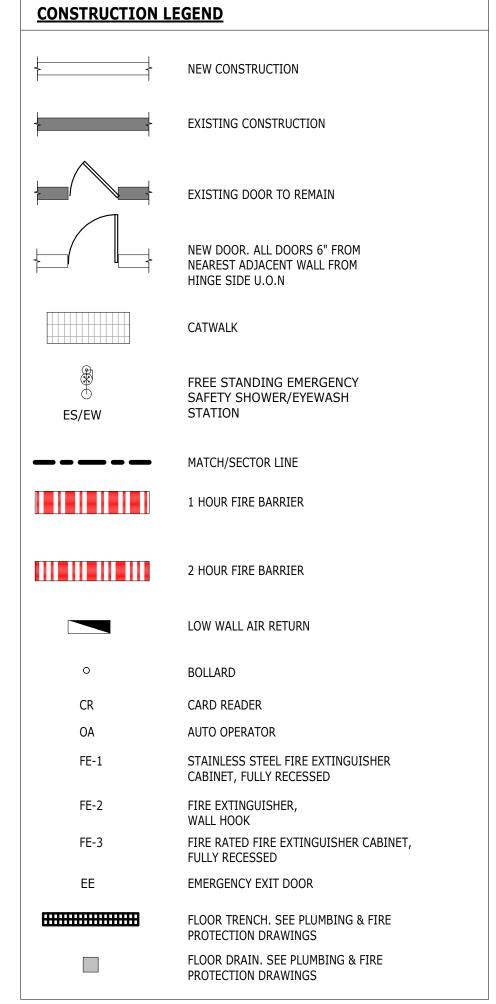

GENERAL NOTES


- REFER TO SHEET ZSPTX-G-0002 FOR GENERAL NOTES, SYMBOLS, AND ABBREVIATIONS.
- 2. VERIFY IN FIELD ALL COLUMNS DIMENSIONS. COLUMN ENCLOSURES TO BE HELD TIGHT AGAINST FIRE- PROOFED COLUMNS.
- 3. ALL EXPOSED/VISIBLE EXISTING CABLE RELATED TO ANY AND ALL SERVICES NOT LIMITED TO MECHANICAL, ELECTRICAL, DATA, SECURITY, FIRE ALARM, PLUMBING TO BE NEATLY ORGANIZED BY CONTRACTOR.
- 4. CONTRACTOR REQUIRES ARCHITECTS APPROVAL AND SIGN OFF ON MOCK UP AT ANY AN ALL AREAS WHERE THIS CONDITION EXISTS.
- 5. CONTRACTOR IS RESPONSIBLE FOR REPAIRING ANY DAMAGE TO RATED PARTITIONS AS A RESULT OF THIS WORK. THE INTEGRITY OF ALL RATED PARTITIONS IS TO BE MAINTAINED DURING CONSTRUCTION.
- 6. ALL DOORS TO BE OFFSET 6" FROM ADJACENT PARTITION.
- 7. LOW WALL AIR RETURNS SIZES AND LOCATIONS TO BE COORDINATED WITH MECHANICAL DRAWINGS.
- 8. PROVIDE EQUIPMENT PAD IN UTILITY ROOMS.
- 9. COORDINATE PAD SIZES AND LOCATIONS WITH ELECTRICAL AND PLUMBING MECHANICAL AND PROCESS DRAWINGS FOR REQUIRED EQUIPMENT. PAD SIZES AND LOCATIONS TO BE DEPENDENT ON FINAL SELECTION OF EQUIPMENT.







Structural Engineers

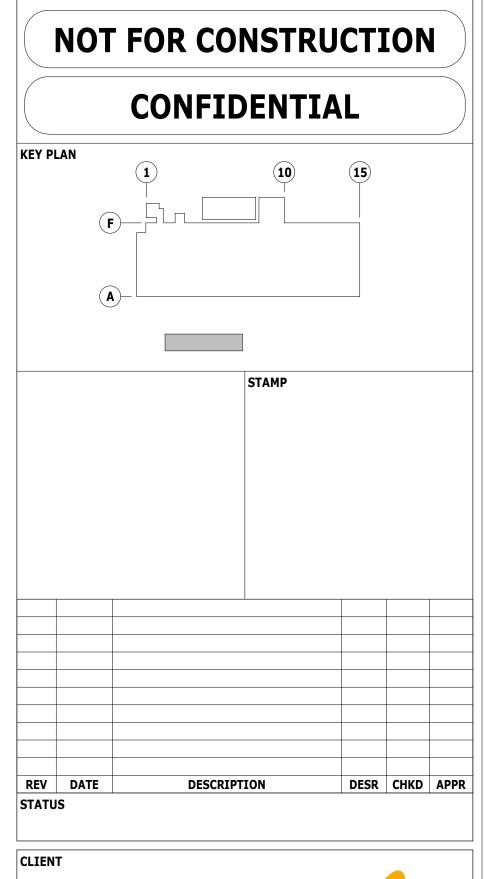

1/8" = 1'-0"

CONSTRUCTION FLOOR PLAN

LEVEL 01 -

DRAWING NO.

ZSPTX-AE-0102


AstraZeneca 2


THIS DRAWING IS THE PROPERTY OF DPS AND SHALL BE USED ONLY FOR THE PURPOSE FOR WHICH IT WAS ISSUED.

IT SHALL NOT BE COPIED, REPRODUCED OR OTHERWISE USED, NOR SHALL SUCH INFORMATION BE FURNISHED IN WHOLE OR IN PART TO OTHERS EXCEPT IN ACCORDANCE WITH THE TERMS OF ANY AGREEMENT UNDER WHICH THIS DRAWING WAS ISSUED, OR WITH PRIOR WRITTEN CONSENT OF DPS, AND SHALL BE RETURNED UPON REQUEST.

ASTRAZENECA - TANK FARM

CLIENT NO.

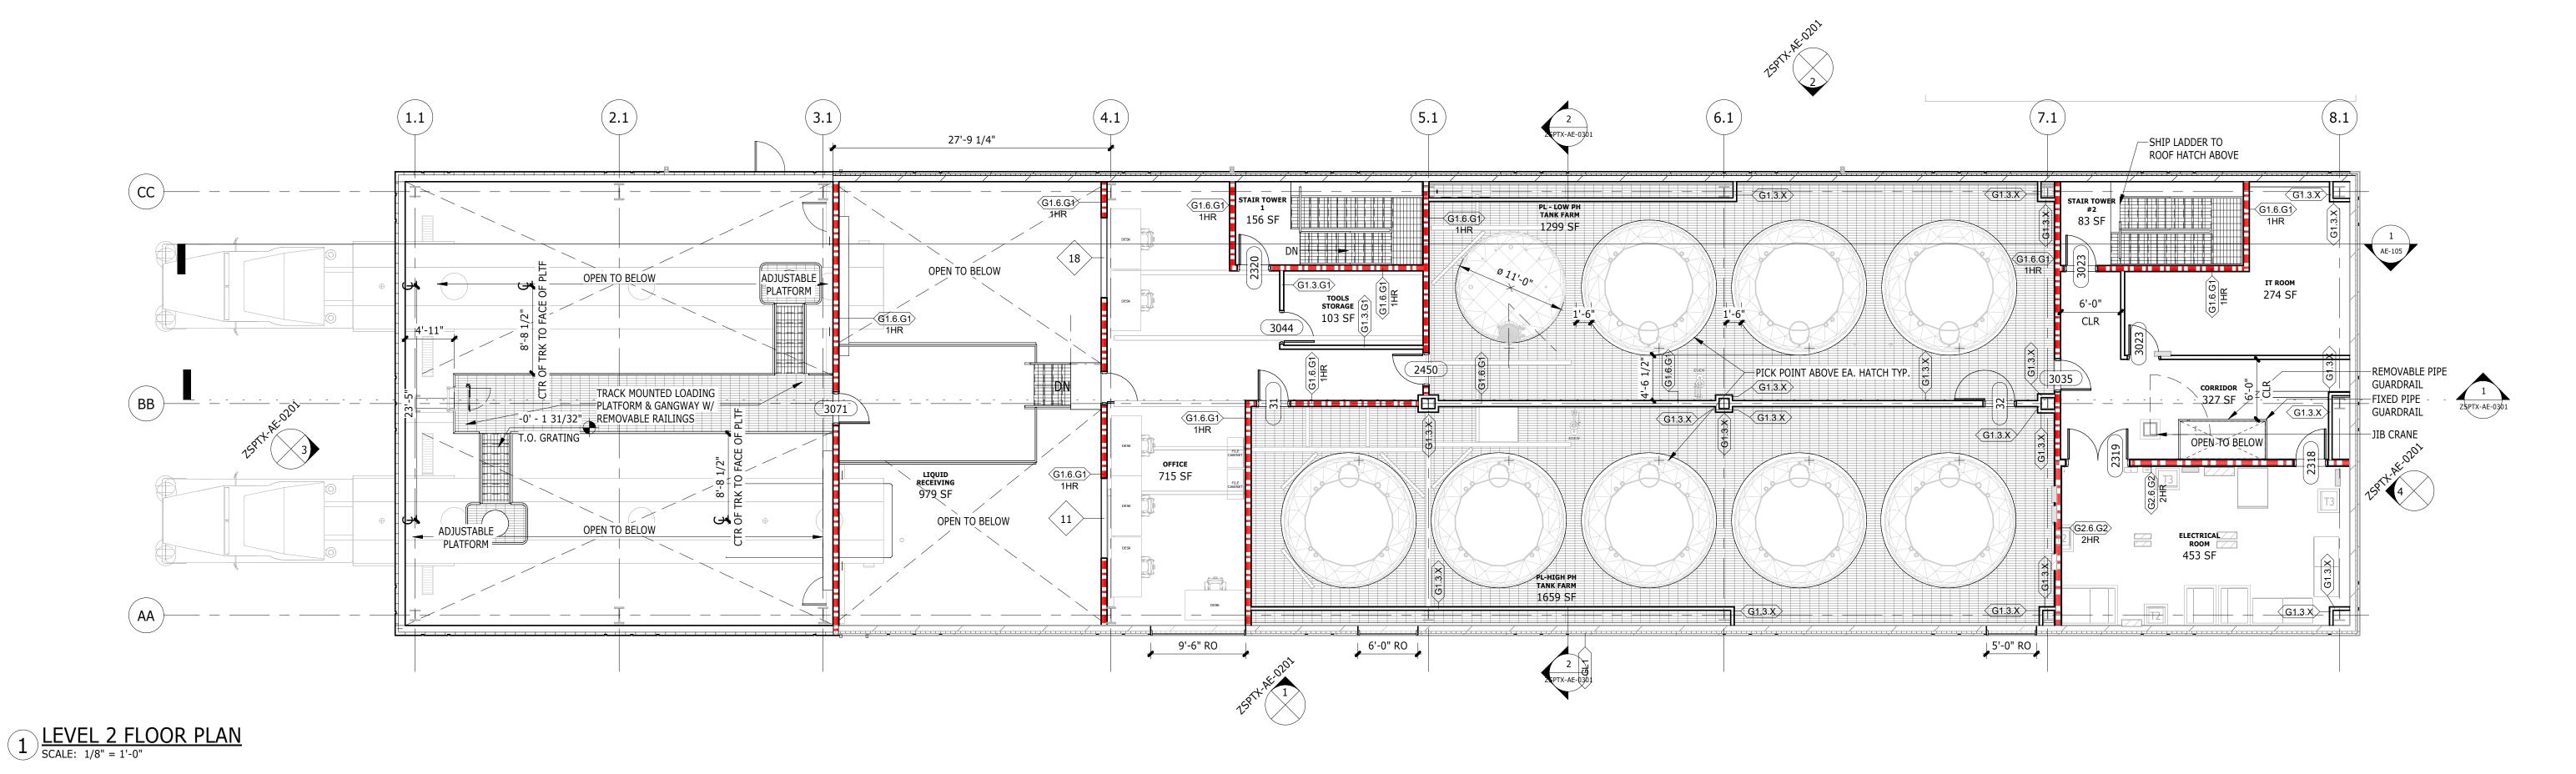

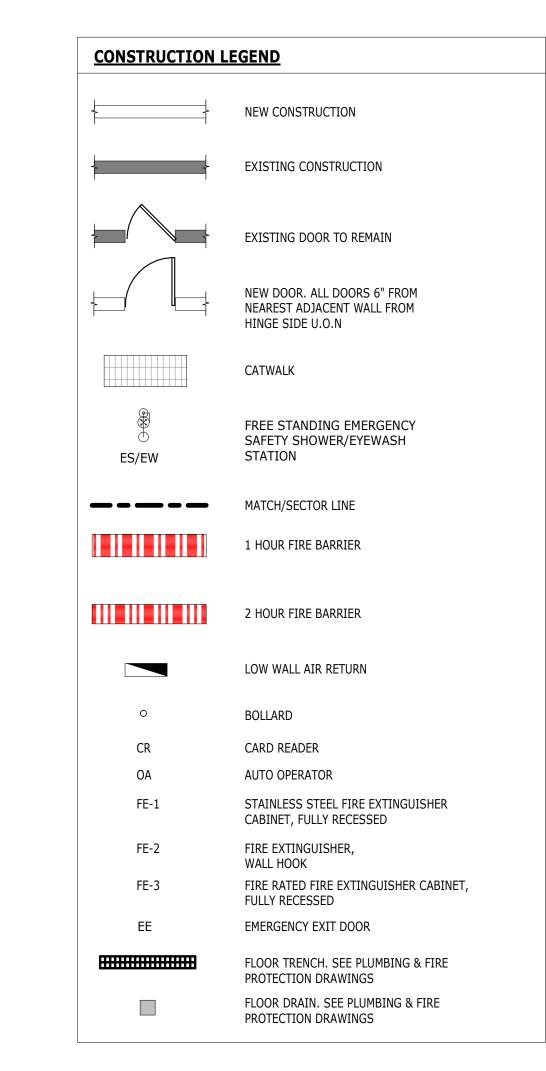

GENERAL NOTES


- REFER TO SHEET ZSPTX-G-0002 FOR GENERAL NOTES, SYMBOLS, AND ABBREVIATIONS.
- 2. VERIFY IN FIELD ALL COLUMNS DIMENSIONS. COLUMN ENCLOSURES TO BE HELD TIGHT AGAINST FIRE- PROOFED COLUMNS.
- 3. ALL EXPOSED/VISIBLE EXISTING CABLE RELATED TO ANY AND ALL SERVICES NOT LIMITED TO MECHANICAL, ELECTRICAL, DATA, SECURITY, FIRE ALARM, PLUMBING TO BE NEATLY ORGANIZED BY CONTRACTOR.
- 4. CONTRACTOR REQUIRES ARCHITECTS APPROVAL AND SIGN OFF ON MOCK UP AT ANY AN ALL AREAS WHERE THIS CONDITION EXISTS.
- 5. CONTRACTOR IS RESPONSIBLE FOR REPAIRING ANY DAMAGE TO RATED PARTITIONS AS A RESULT OF THIS WORK. THE INTEGRITY OF ALL RATED PARTITIONS IS TO BE MAINTAINED DURING CONSTRUCTION.
- 6. ALL DOORS TO BE OFFSET 6" FROM ADJACENT PARTITION.
- 7. LOW WALL AIR RETURNS SIZES AND LOCATIONS TO BE COORDINATED WITH MECHANICAL DRAWINGS.
- 8. PROVIDE EQUIPMENT PAD IN UTILITY ROOMS.
- 9. COORDINATE PAD SIZES AND LOCATIONS WITH ELECTRICAL AND PLUMBING MECHANICAL AND PROCESS DRAWINGS FOR REQUIRED EQUIPMENT. PAD SIZES AND LOCATIONS TO BE DEPENDENT ON FINAL SELECTION OF EQUIPMENT.







Structural Engineers

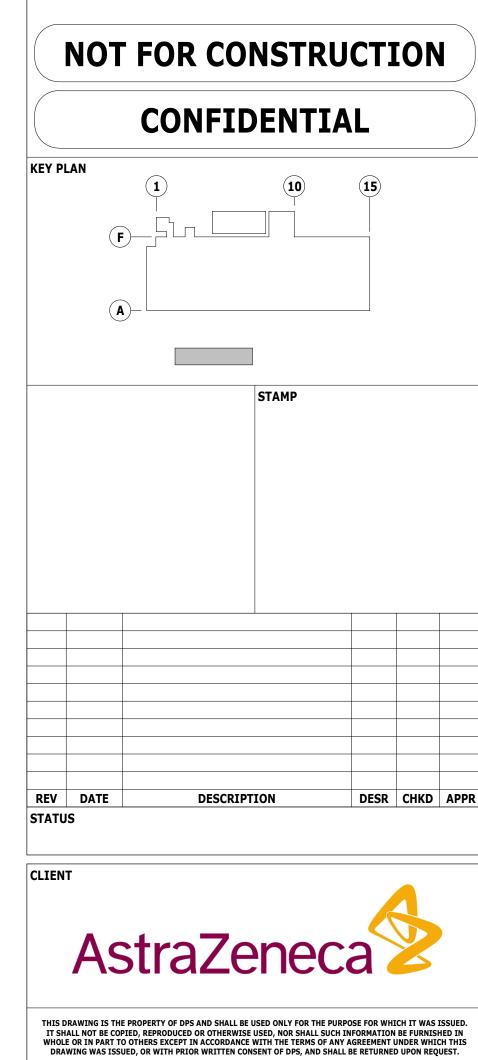

ASTRAZENECA - TANK FARM

CLIENT NO.

CONSTRUCTION FLOOR PLAN


1/8" = 1'-0"


Autodesk Docs://D22BP111-AstraZeneca Tank Farm & E-Gen/D22BP111-DPS-ZZ-ZZ-M3-A-0001.rvt 7/14/2023 1:40:23 PM

LEVEL 02 -

DRAWING NO.

ZSPTX-AE-0103

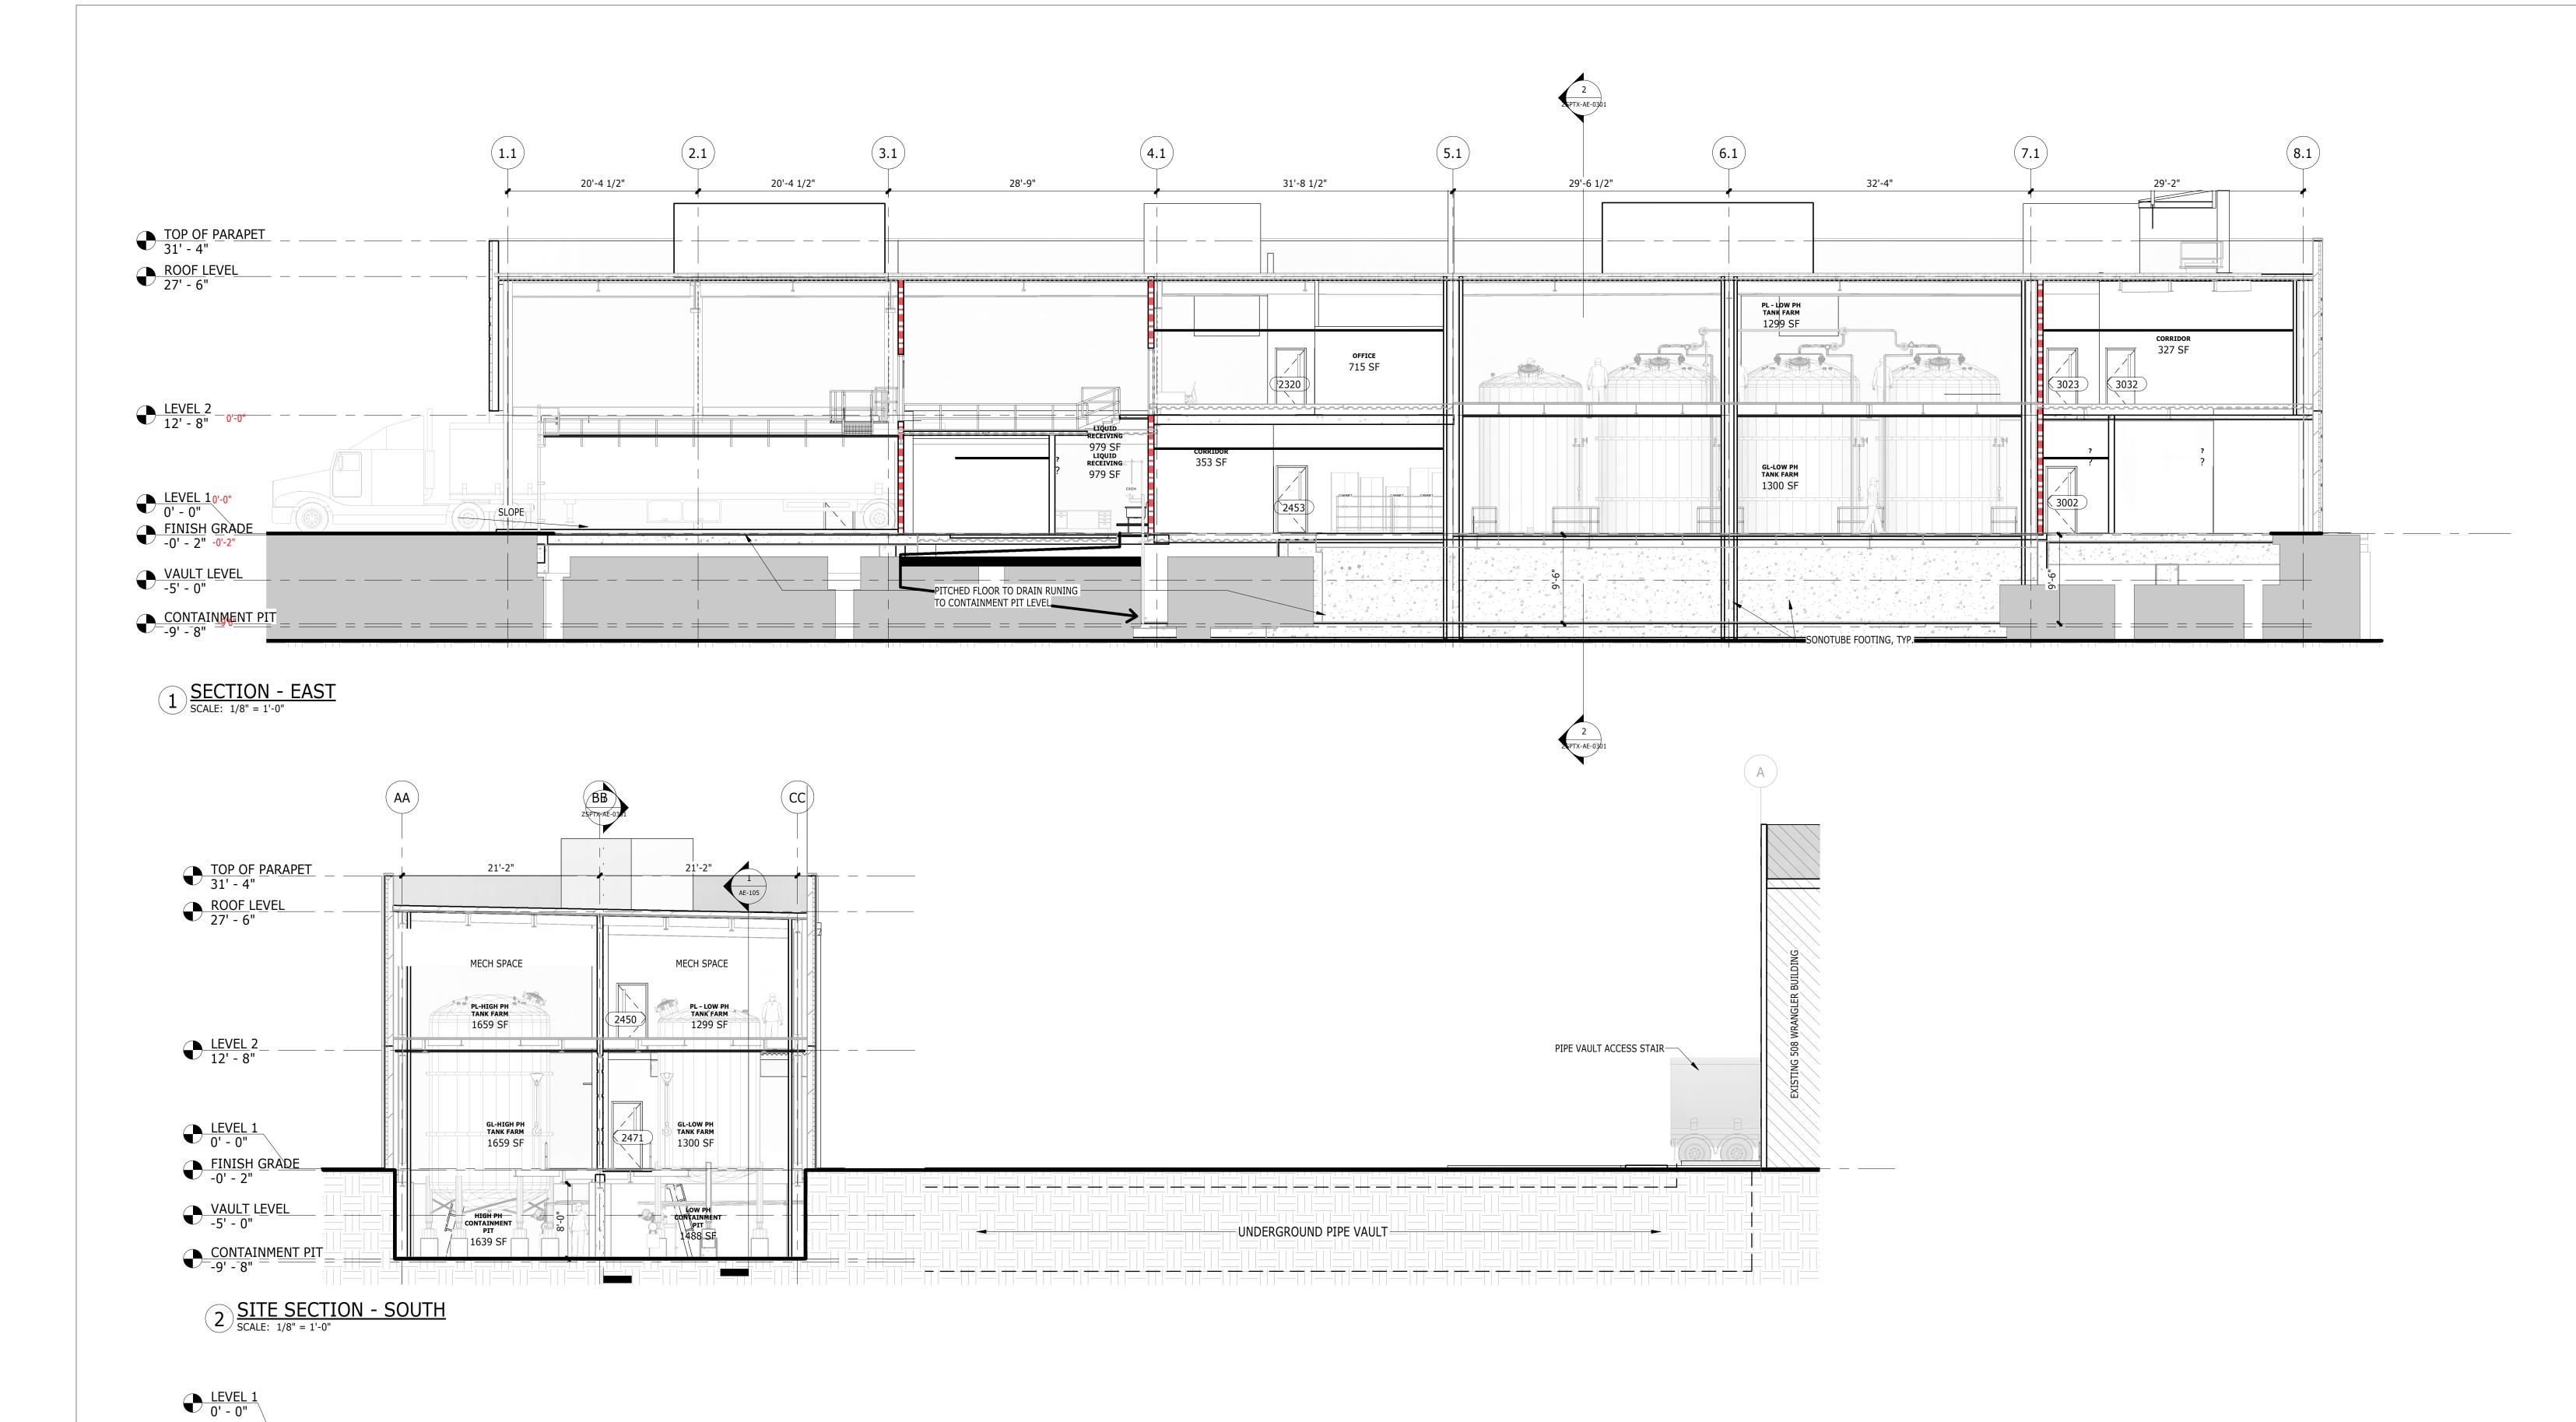

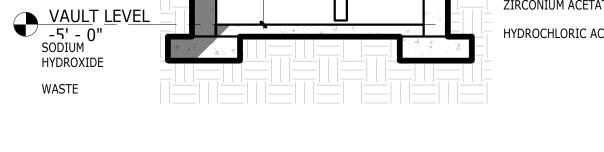



COLLIDAL SILLICA

COMPRESSED AIR

ZIRCONIUM ACETATE

HYDROCHLORIC ACID

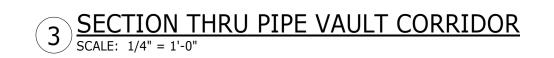

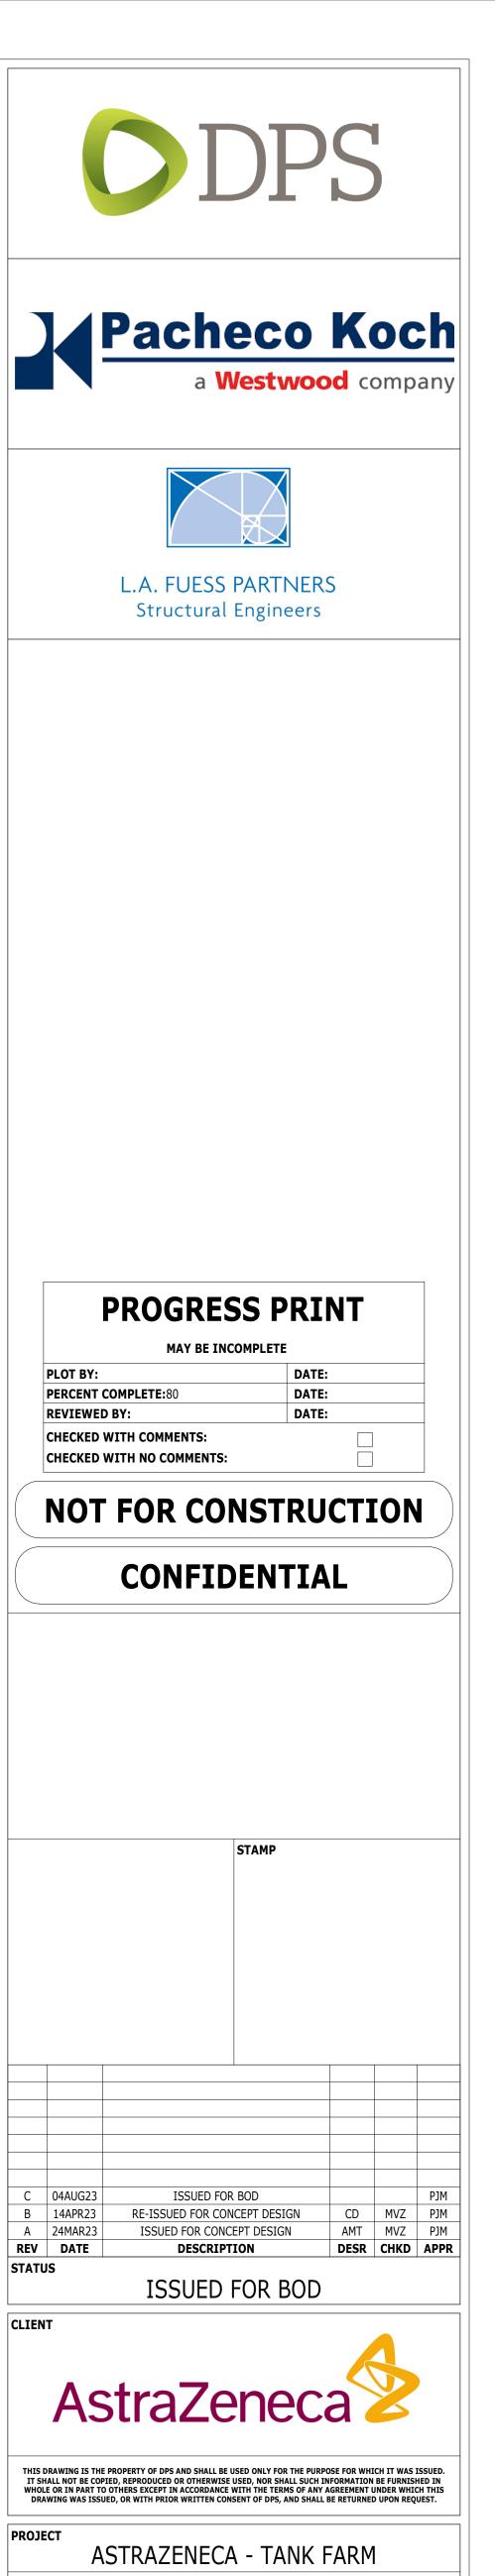

BUILDING SECTIONS

DRAWING NO.

ZSPTX-AE-0301

AS INDICATED

Autodesk Docs://D22BP111-AstraZeneca Tank Farm & E-Gen/D22BP111-DPS-ZZ-ZZ-M3-A-0001.rvt 7/14/2023 1:40:49 PM

CLIENT NO.