

KEYNOTES BY SYMBOL

01	MODULAR BRICK - (FIELD) (BRICK-1) BY ACME BRICK CO. SET IN RUNNING BOND PATTERN. REFERENCE SHEET A301 FOR BRICK & STONE DESCRIPTION FOR COLOR/MANUF.	10	(STONE-5) CAST STONE AT WINDOW SURROUND. REFERENCE XXXXXXX FOR JOINT PATTERN.	19	VERTICAL BRICK CONTROL JOINT	27	EXISTING EXTERIOR MASONRY WALL CONSTRUCTION	36	EXTRUDED ALLOY ALUMINUM BEAM, TUBE TRELLIS AND STEEL COLUMN EQUAL TO AVADEK.
02	MODULAR BRICK - (FIELD) (BRICK-2) BY ACME BRICK CO. SET IN RUNNING BOND PATTERN. REFERENCE SHEET A301 FOR BRICK & STONE DESCRIPTION FOR COLOR/MANUF.	11	AUTOMATIC BI-PARTING SLIDING DOORS (CLEAR ANODIZED FINISH) REF. DOOR SCHEDULE.	20	NATURAL TEXAS LIMESTONE BLEND (STONE-1) "ROUGH BACK" BY TEXAS QUARRIES.	28	24" DIA. EXTRUDED ALLOY ALUMINUM SIDE-LOCK COLUMN COVER. SATIN BRUSH FINISH.	36	NATURAL TEXAS LIMESTONE BLEND (STONE-7) "ROUGH BACK" BY TEXAS QUARRIES (STEM WALL).
03	BRICK - (ACCENT) (BRICK-3) BY ACME BRICK CO. SET IN RUNNING BOND PATTERN. BRICK SHALL BE SET BACK 3" FROM FACE OF ADJACENT BRICK. REFERENCE SHEET A301 FOR BRICK & STONE DESCRIPTION FOR COLOR/MANUF.	12	EXTRUDED ALLOY ALUMINUM OVERHEAD SUPPORTED CANOPY W/ PIPE BRACE EQUAL TO AVADEK.	21	HATCHED AREA INDICATES 1" INSULATED LOW E GLASS IN ANODIZED ALUMINUM WINDOW SYSTEM WITH APPLIED SCREEN GRAPHIC PATTERN.	29	EXISTING EXTERIOR MASONRY CLEARSTORY DORMER.	37	NOMINALLY 4" THICK CAST STONE CAP (STONE-8) W/ 1" PROJECTION OVER TOP OF STEM WALL. CAST STONE CAP SHALL NOT EXCEED 48" LONG. CAST STONE CAP SHALL BE EVENLY SPACED ALONG LENGTH. CAST STONE CAP SHALL PROJECT 1" FROM ADJACENT STONE SURFACE.
04	UTILITY BRICK (BASE) (BRICK-4) BY ACME BRICK CO. SET IN SPECIFIC PATTERN (REF. 02/A301). REFERENCE SHEET A301 FOR BRICK & STONE DESCRIPTION FOR COLOR/MANUF.	13	SURFACE MOUNTED EXTERIOR LIGHT FIXTURE TYPE "XX" REF. LIGHT FIXTURE SCHEDULE ON SHEET A213.	22	NOMINALLY 4" THICK CAST STONE CAP (STONE-4) TAPERED 1" TO EACH SIDE. CAST STONE CAP SHALL NOT EXCEED 48" LONG. CAST STONE CAP SHALL BE EVENLY SPACED ALONG LENGTH.	30	EXISTING STANDING SEAM METAL ROOF SYSTEM.		
05	10" HIGH (OVERALL) VARYING PROFILED CAST STONE COPING (STONE-2). CAST STONE COPING SHALL NOT EXCEED 48" LONG. CAST STONE COPING SHALL BE EVENLY SPACED ALONG LENGTH. CORNERS SHALL BE MITERED.	14	HOLLOW METAL DOOR AND FRAME. DOOR AND FRAME TO BE PAINTED (PT-4)	23	BUILDING SIGNAGE REF. XXXXXXX FOR ENLARGED ELEVATION AND DETAILS	31	TWO-PIECE CAST STONE CAP (OVERALL THICKNESS 10 3/4" - (STONE-6). CAST STONE CAP SHALL NOT EXCEED 48" LONG. CAST STONE CAP SHALL BE EVENLY SPACED ALONG LENGTH. CAST STONE CAP SHALL PROJECT 1" FROM ADJACENT STONE SURFACE.		
06	(STONE-3) 4" HIGH CAST STONE BAND. PROJECTED 1" FROM FACE OF BRICK. CAST STONE SHALL NOT EXCEED 48" LONG. CAST STONE SHALL BE EVENLY SPACED ALONG LENGTH.	15	OVERFLOW NOZZLE WITH FLANGE ESCUTCHEON PLATE MOUNT 24" A.F.F. TO CENTERLINE.	24	MANUAL BUILDING MOUNTED DRIVE-UP BOOK DROP. REF. XXXXXXX FOR TYPE OF UNIT AND MOUNTING DETAILS.	32	EXISTING CAST-IN-PLACE CONCRETE COLUMN ENCLOSURE AND STEEL TRUSS.		
07	1" INSULATED LOW E GLASS IN ANODIZED ALUMINUM WINDOW SYSTEM TYP. U.I.O. FOR APPLIED SILK-SCREEN.	16	FREEZE PROOF HOSE BIB. MOUNT HOSE BIB 2'-4" A.F.F.	25	7 1/2" HIGH (OVERALL) CAST STONE BAND (STONE-3). CAST STONE BAND SHALL NOT EXCEED 48" LONG. CAST STONE BAND SHALL BE EVENLY SPACED ALONG LENGTH. CAST STONE BAND SHALL PROJECT 3" FROM ADJACENT BRICK SURFACE.	33	EXTRUDED ALLOY ALUMINUM TUBE TRELLIS AND COLUMNS EQUAL TO AVADEK.		
08	ANODIZED HORIZONTAL EXTENSION COVER TO MATCH WINDOW SYSTEM	17	RECESSED WALL MOUNTED KNOW BOX.	26	EXISTING GLASS AND ALUMINUM WINDOW SYSTEM.	34	SECURITY ACCESS AND AUDIBLE SIGNALING SYSTEM FOR STAFF ACCESS.		
09	3'-0" X 7'-0" ANODIZED ALUMINUM DOOR W/ 1" INSULATED LOW E GLASS - REF. DOOR SCHEDULE FOR DOOR TYPE	18	GFI RECEPTACLE MOUNTED 1'-6" AFF. REF. ELECTRICAL DWGS.						

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TITLE

EXTERIOR ELEVATIONS

REVISIONS

JOB NO. 20311

Issue Date: 3.5.2015

Drawn By: DZ

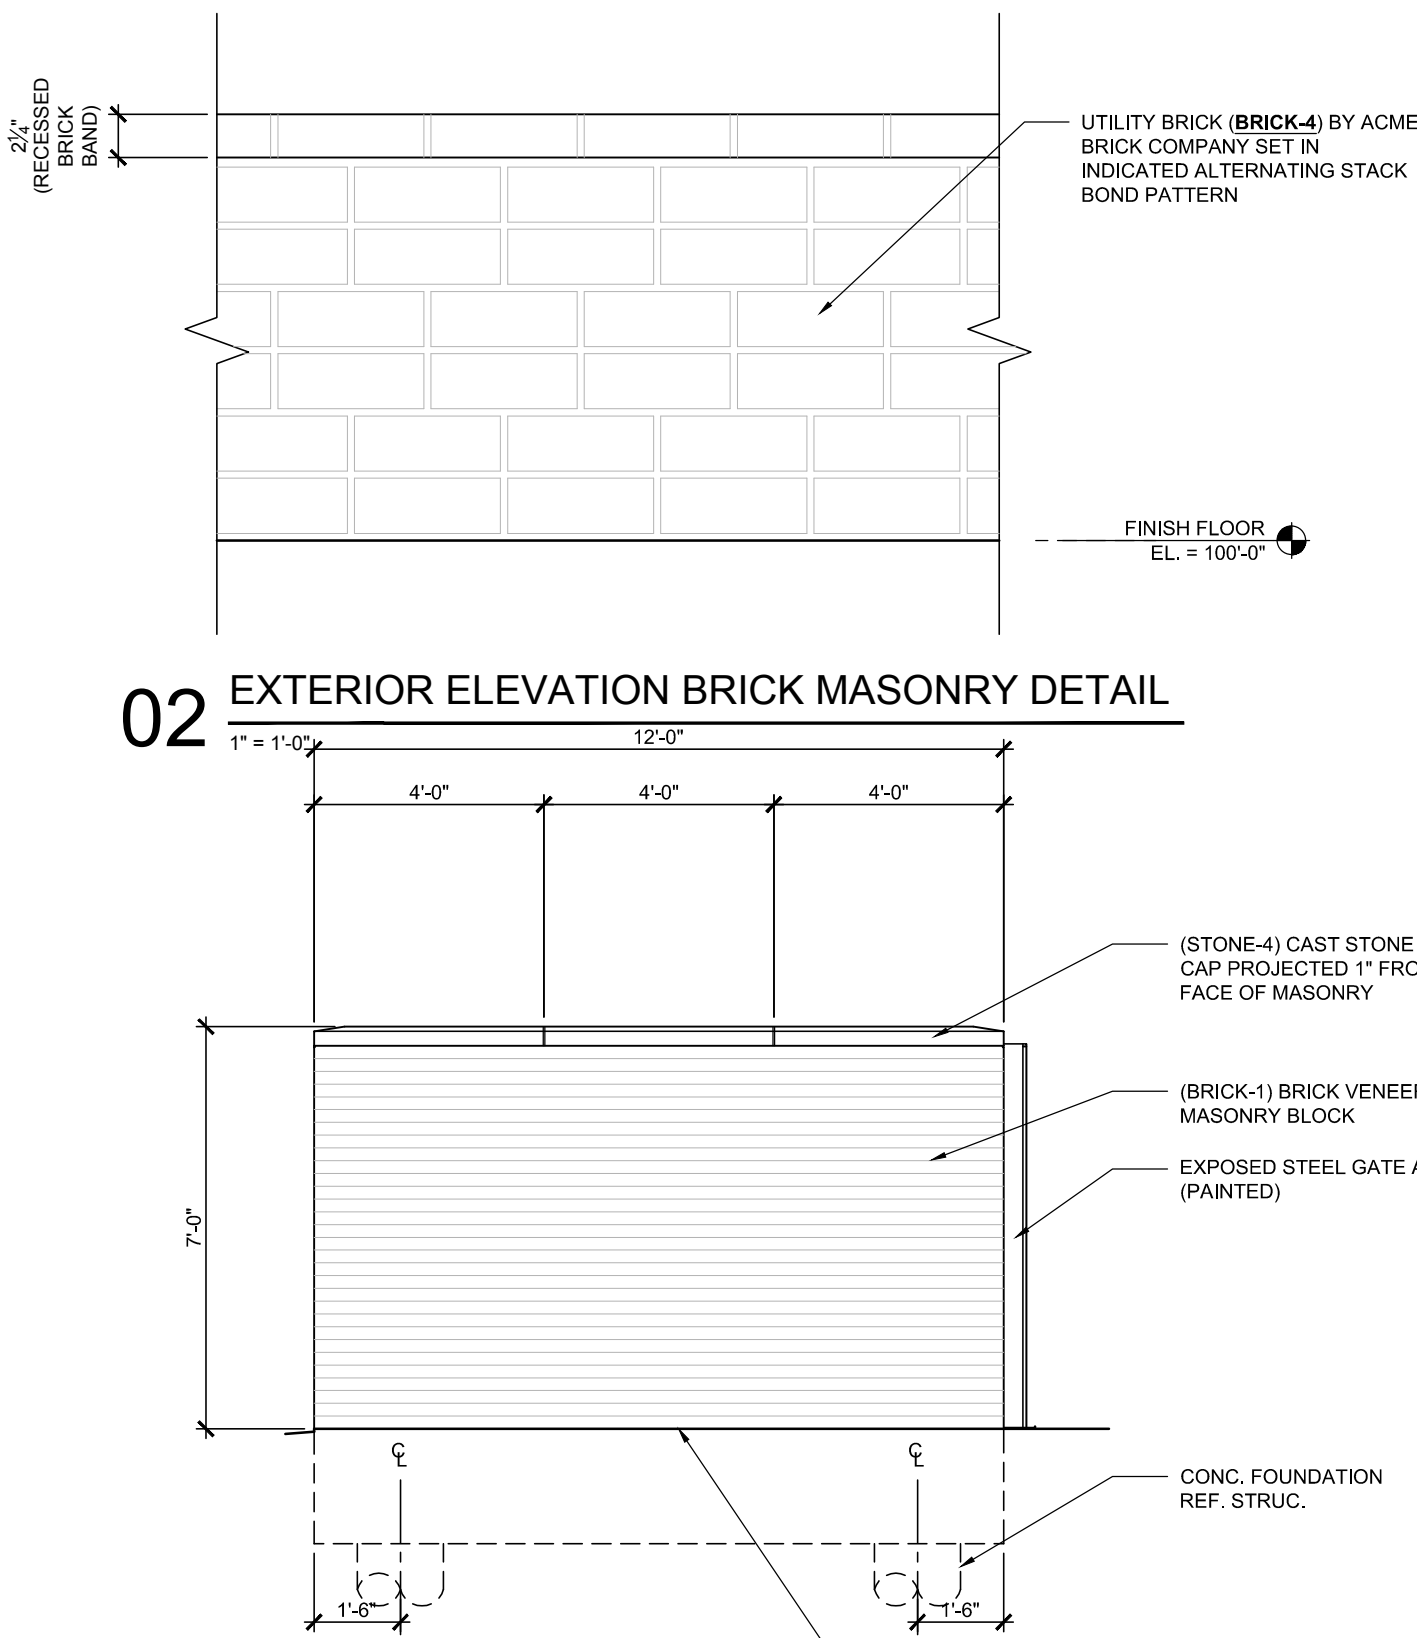
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SHEET NO.

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P & Z SUBMISSION

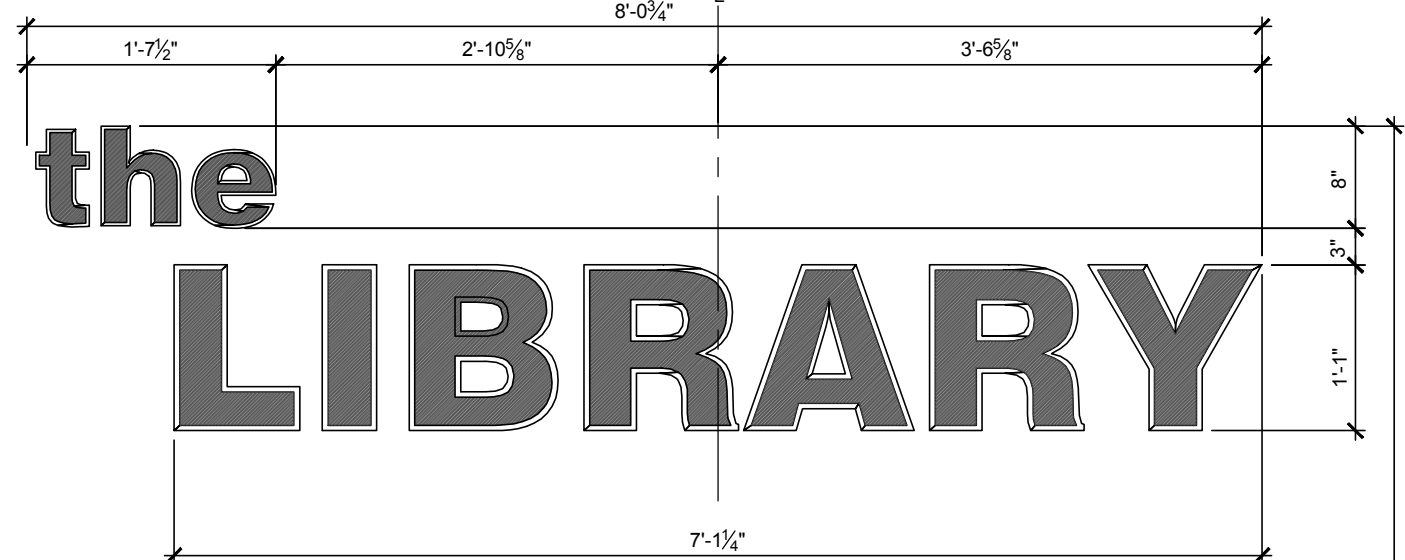
02 EXTERIOR ELEVATION BRICK MASONRY DETAIL



05 TRASH ENCLOSURE ELEVATION

3/8" = 1'-0"

REF. CIVIL DRAWINGS FOR GRADE ELEVATIONS

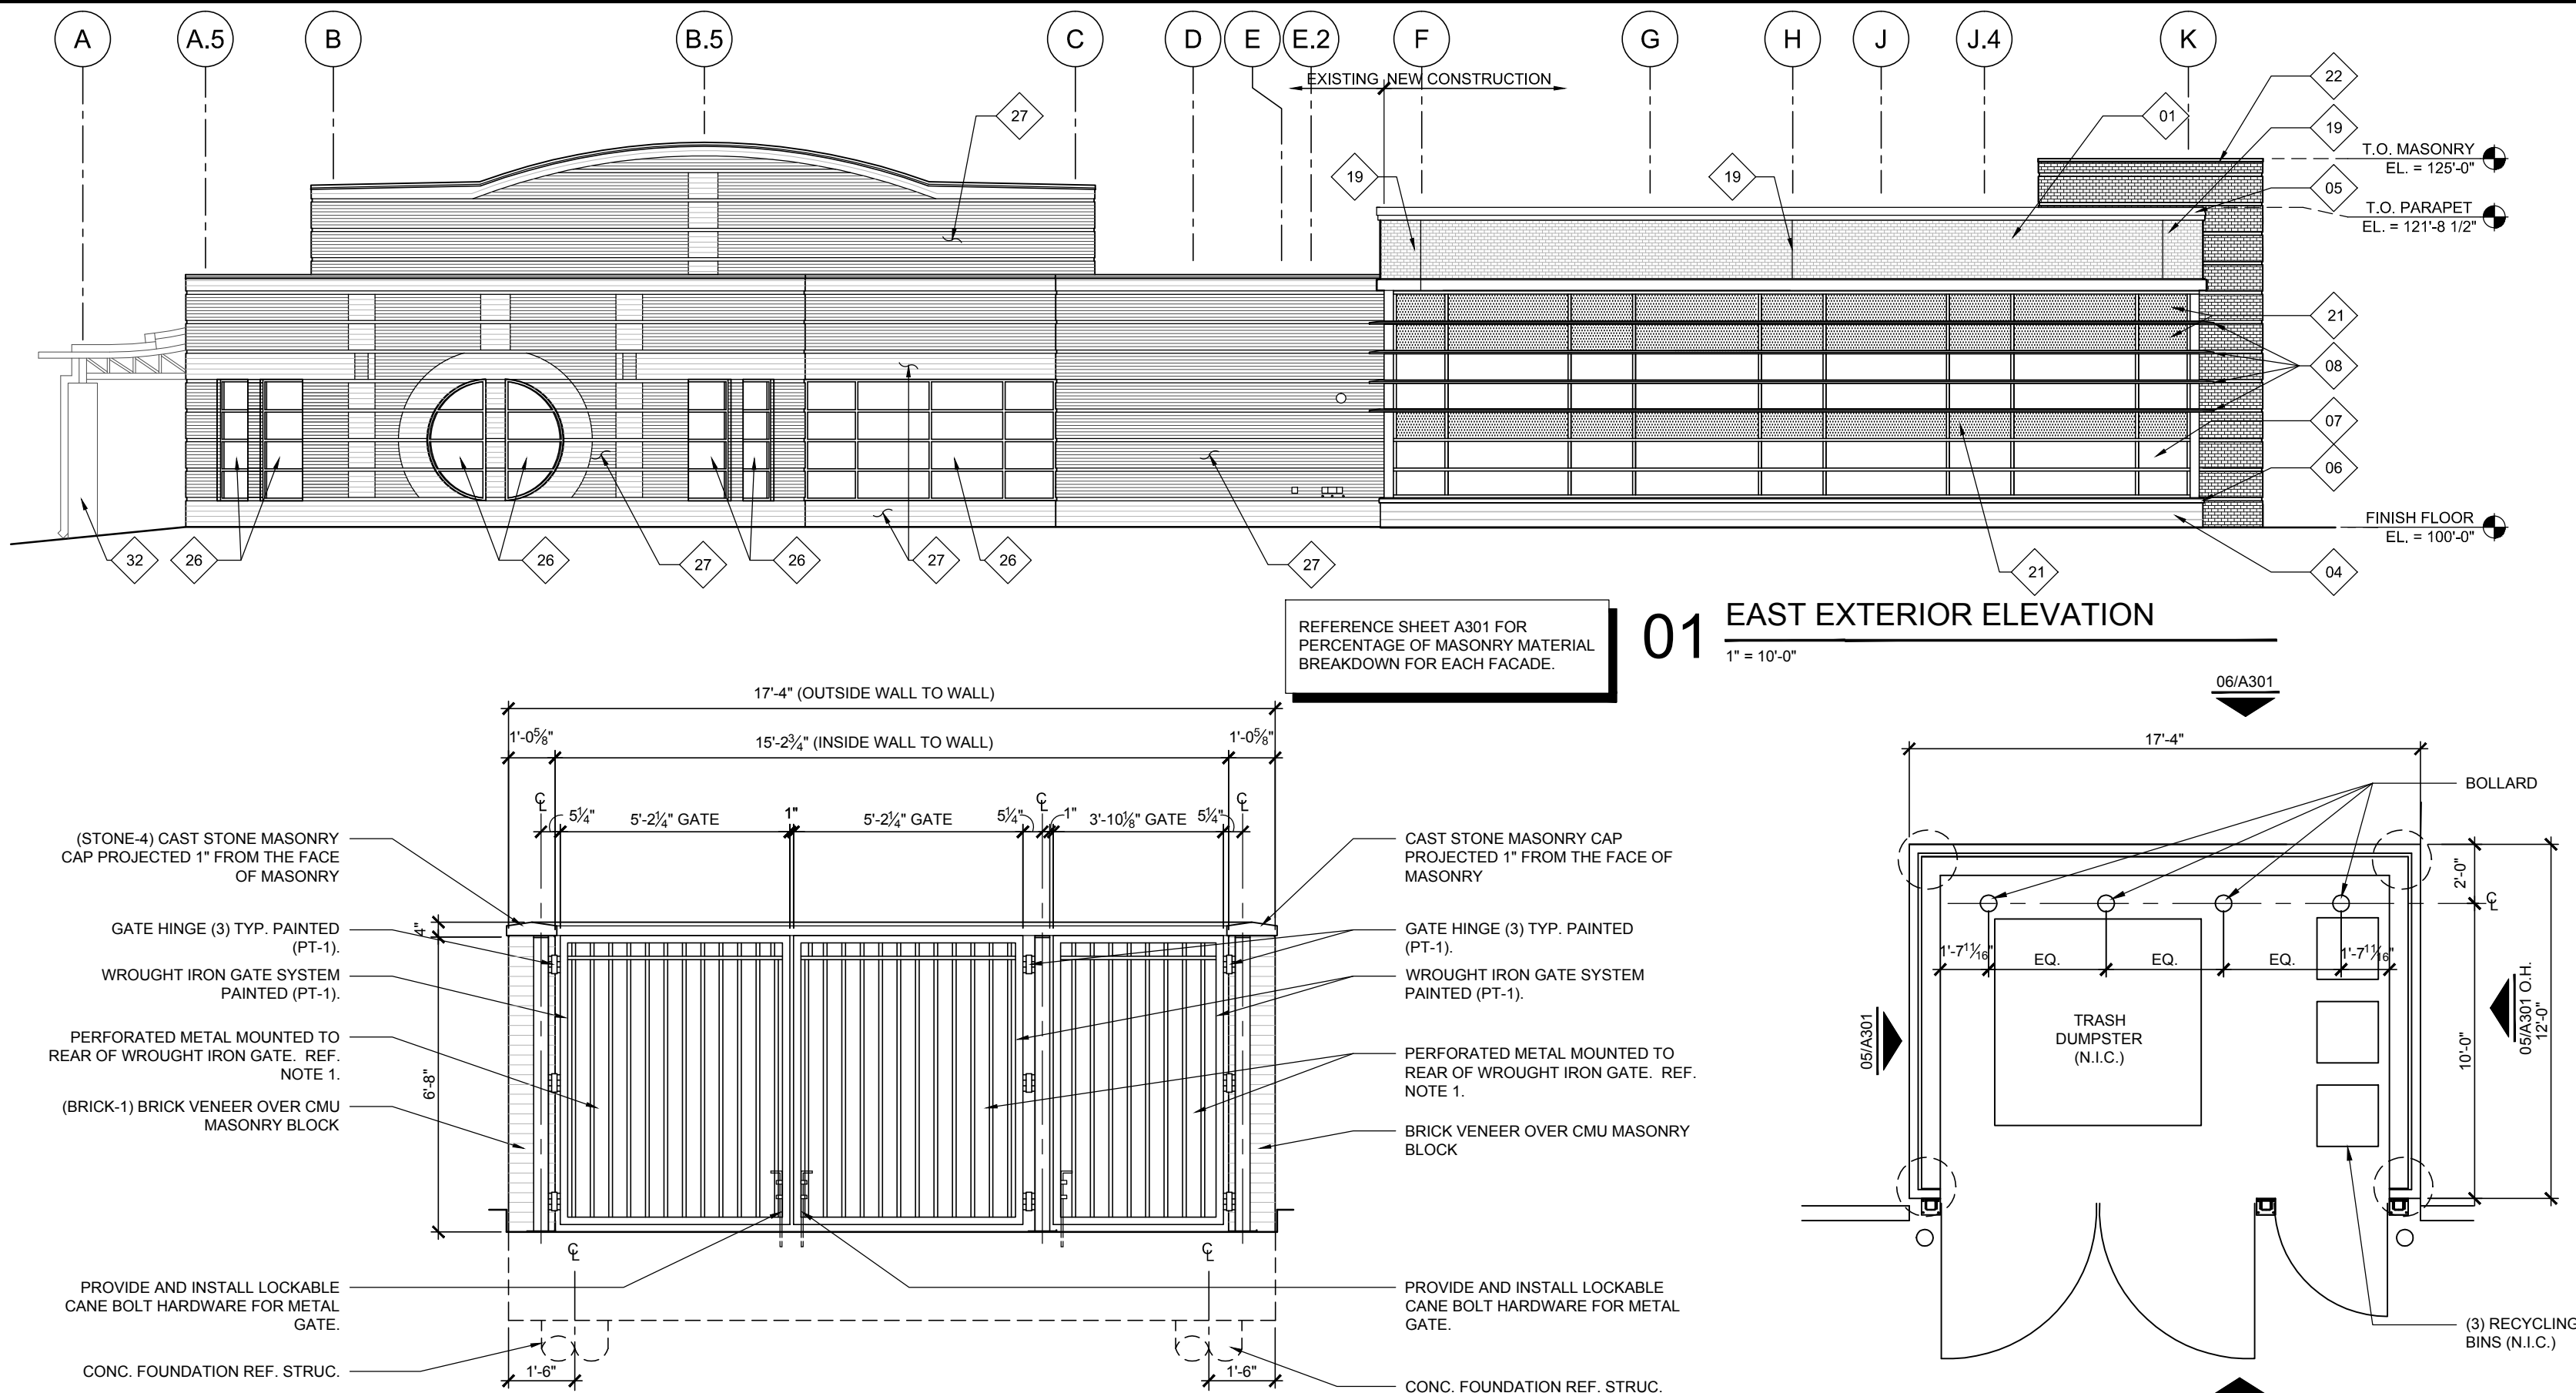


08 BUILDING SIGNAGE DETAILS

3/4" = 1'-0"

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01 EAST EXTERIOR ELEVATION

1" = 10'-0"

04 TRASH ENCLOSURE ELEVATION

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