

Luminaire S	Schedule												
Symbol	Qty	Label		Arrangement	Total Lamp Lu	Total Lamp Lumens LLF Description							
G	9	L-25		SINGLE	N.A.	0.	.800	TRP2-D-20-4K7-FT / HUBBELL FORWARTHROW WALLPACK, FULL CUT-OFF. MOU AT 12' HEIGHT.					
Ð	1	L-30		SINGLE	N.A.	0.	.900	TYPE III	DSX1 LED P6 40K T3M EGS / LITHONIA TYPE III LUMINAIRE WITH EXTERNAL GLARE SHIELD. MOUNT ON 25' DARK BRONZE POLE.				
0-0	1	L-31		BACK-BACK	N.A.	0.	.900	DSX1 LED P6 40K T3M / LITHONIA TYPE III LUMINAIRE. MOUNT ON 25' DARK BRONZE POLE.					
1	3	L-33		3 @ 90 DEGREES	N.A. 0.900			DSX1 LED P6 40K T5M / LITHONIA TYPE V LUMINAIRE. MOUNT ON 25' DARK BRONZE POLE.					
Calculation	n Summarv	y				·							
		CalcType		Units /	Avg	Max	Min	Avg/Min	Max/Min				
50' ATM RADIUS		Illuminan	Illuminance Fc		5.52	12.8	2.9	1.90	4.41				
LIGHT SPILL		Illuminan	Illuminance Fc		.27	0.6	0.1	2.70	6.00				
PROPERTY LINE		Illuminan	Illuminance Fc		.25	2.2	0.5	2.50	4.40				
Site Planar		Illuminan	Illuminance Fc		.93	13.1	1.9	2.59	6.89				

SANDY LAKE ROAD

110' PUBLIC RIGHT-OF-WAY

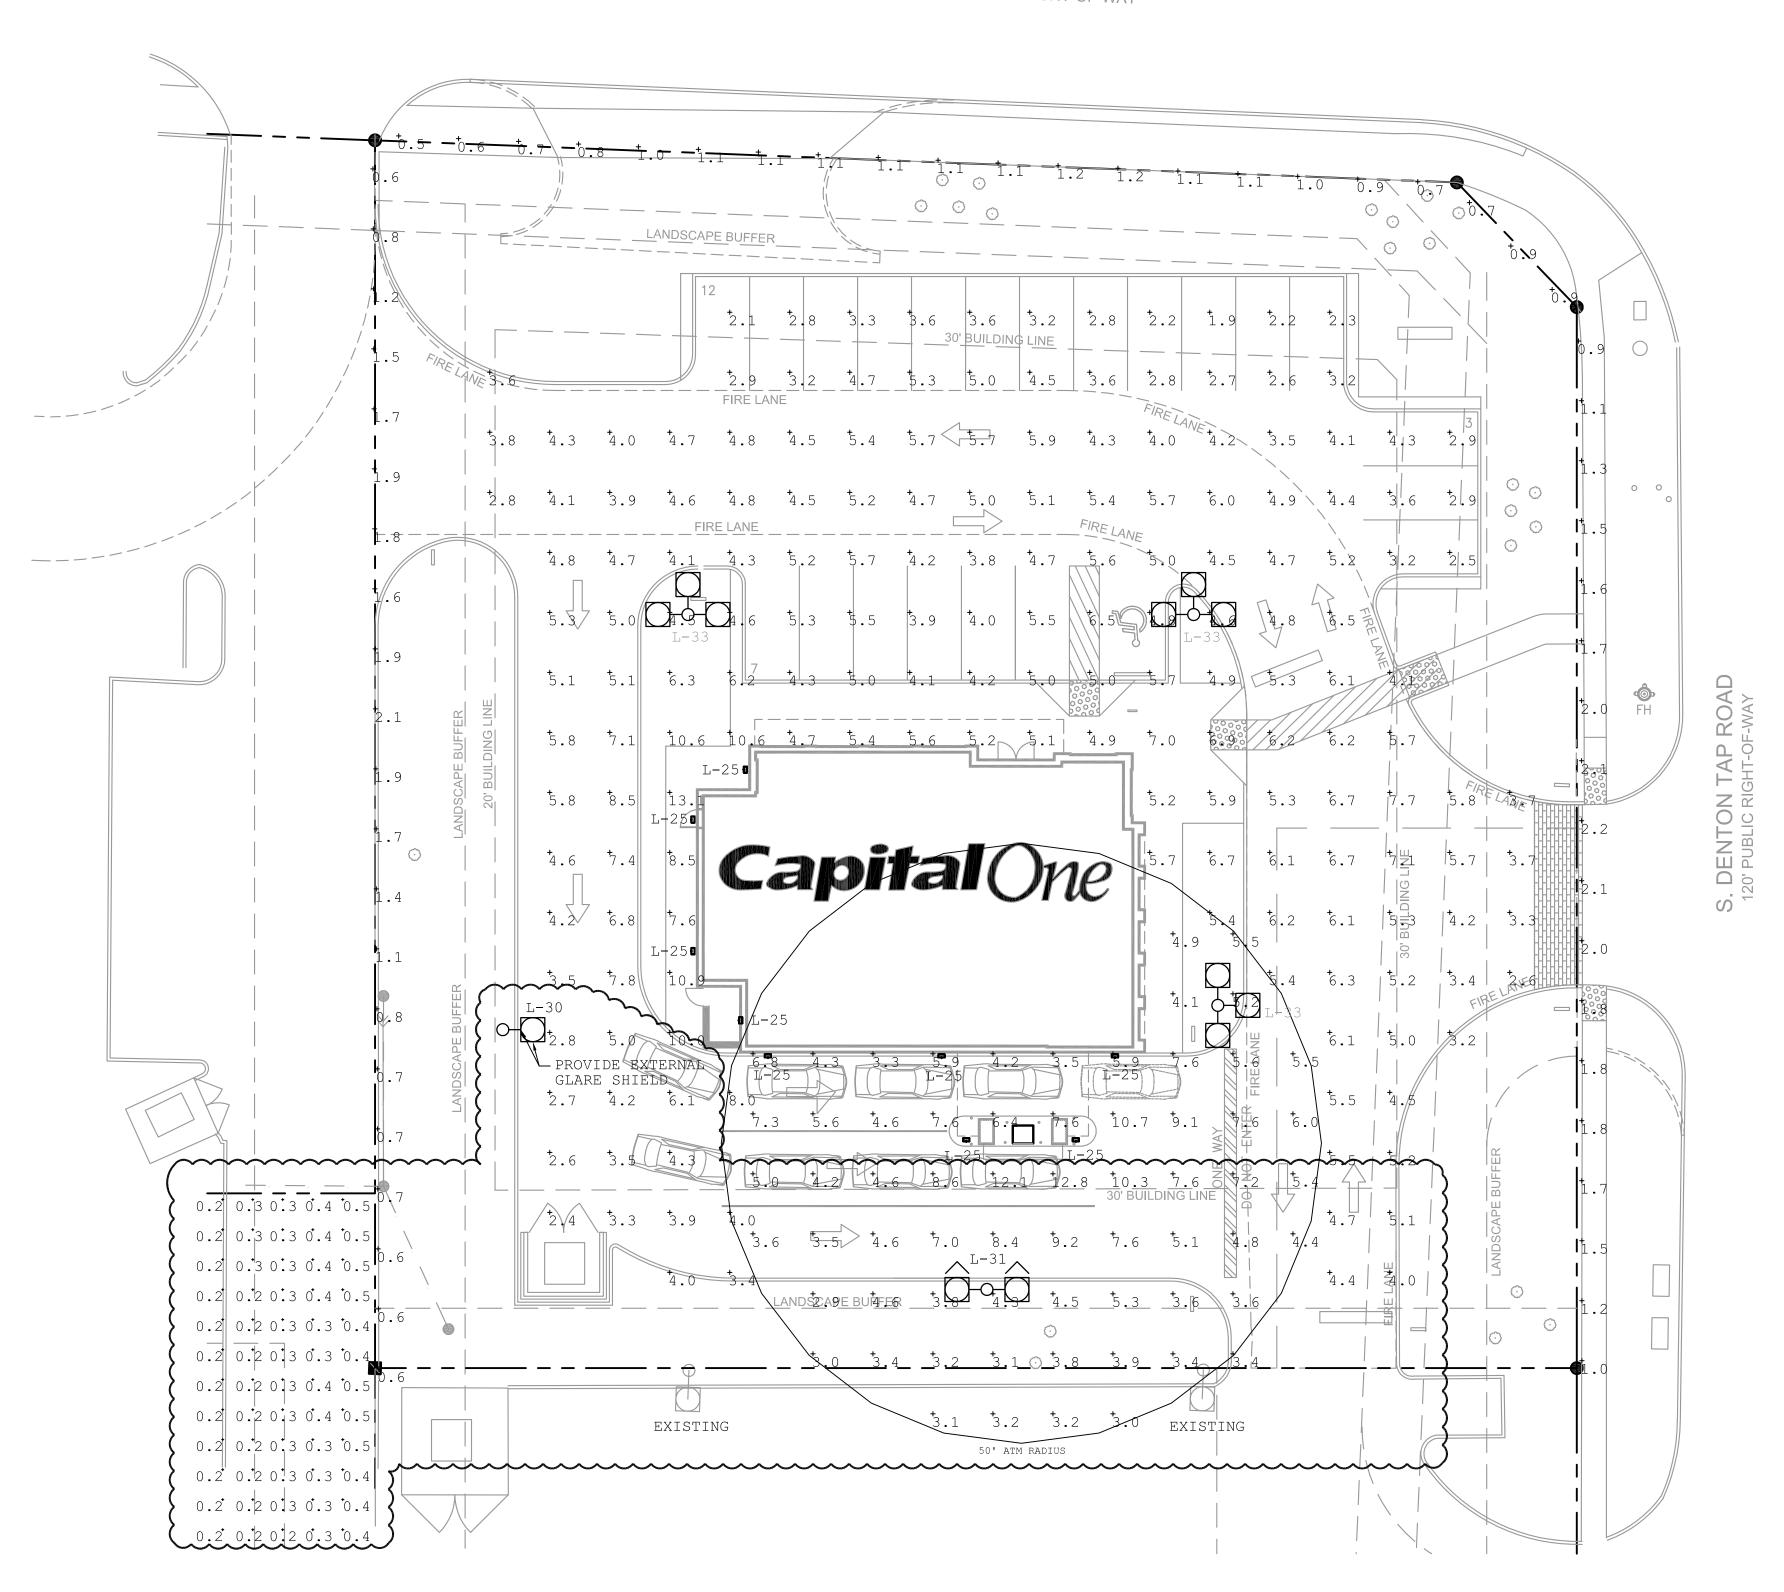

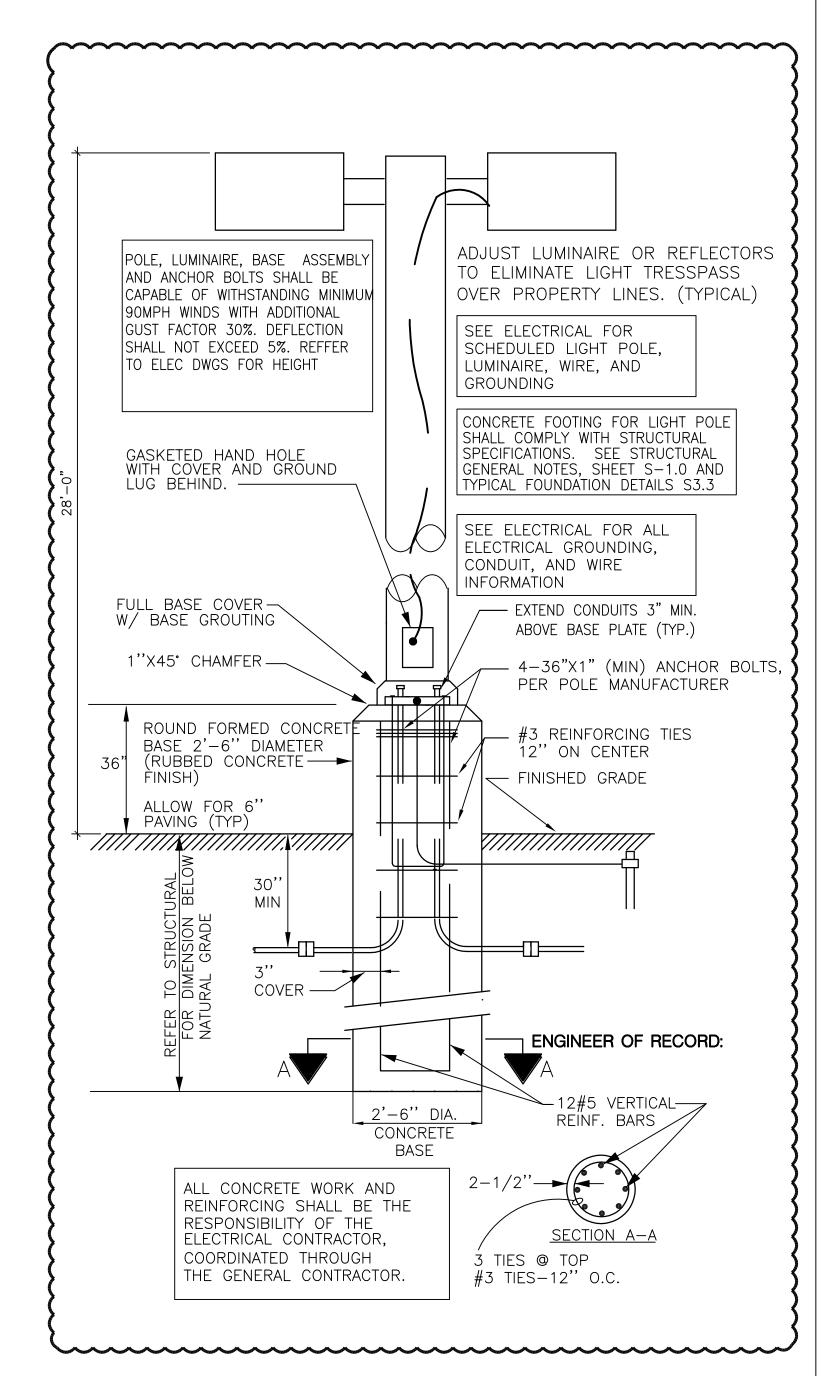

INTERIM REVIEW
DOCUMENTS

THE DESIGN DOCUMENTS DEPICTED HEREIN ARE
FOR THE PURPOSE OF REVIEW AND MAY NOT BE
USED FOR REGULATORY APPROVAL, PERMIT, OR
CONSTRUCTION, UNDER THE AUTHORITY OF
MELVIN KALMANS, P.E. TX. REGISTRATION NO. 24070
ON AUGUST 07, 2018


SALASO'BRIEN

[expect a difference]

l expect a difference | 10930 W. Sam Houston Parkway N., Suite 900 Houston, Texas 77064 281.664.1900 | Registration No. F-4111 Project No. 169-180638 Capital One

Capital One
Design//Branch Cafe Care & Const.
299 Park Ave. 22nd floor
New York, NY. 10171

APITAL ONE BANK
COPPELL
SANDY LAKE CROSSING
LOT 3, BLOCK 1
LOT 3, BLOCK 1
LOT 3, BLOCK 1
NARD A. CROW SURVEY, ABSTRACT NO. 301
S SOUTH DENTON TAP ROAD

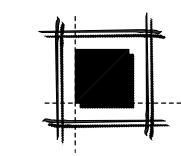

LEVINSON - ALCOSER ASSOCIATES, L. P.

1177 W. Loop South, Suite 900 Houston, Texas 77027 tel 713.787.0000 fax 713.850.8250								
Architecture	Planning	Interior	Design					
DRAWN BY: LT	CHECKED BY: JZ	REVISED BY:	JZ					
REVISIONS			REV.BY					
by U.S. Copyright La Architectural Works reproduction and dis than for use o and may result	son Alcoser Assoc Warn v Under Section 102 of c Copyright Protection tribution of this docum f this particular in severe civil and to the maximum ex	the U.S. Copyright n Act of 1990. Ur ent or any portion project, is p d criminal pena	Act and the nauthorized of it, other rohibited lties, and					

SITE 18-07-000261 P&Z SUBMITTAL 08/07/2018

LAALP Project Number: 2018-108.003

F101

ELECTRICAL SITE PLAN

Issued For Permit:

Issued For Permit:
Issued For Construction:

1 ELECTRICAL PHOTOMETRIC SITE PLAN

SCALE: 1/16" = 1'-0"



D-Series Size 1

LED Area Luminaire












Specifications

pecifications					
1.01 ft ² (0.09 m ²)					
33" (83.8 cm)					
13" (33.0 cm)					




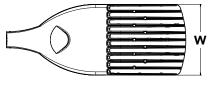







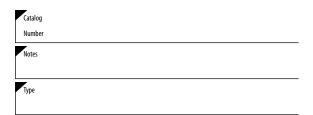

4 Capable Luminaire

This item is an A+ capable luminaire, which has been designed and tested to provide consistent color appearance and system-level interoperability.

- All configurations of this luminaire meet the Acuity Brands' specification for chromatic consistency
- This luminaire is A+ Certified when ordered with DTL® controls marked by a shaded background.
 DTL DLL equipped luminaires meet the A+ specification for luminaire to photocontrol interoperability1
- This luminaire is part of an A+ Certified solution for ROAM® or XPoint™ Wireless control networks, providing out-of-the-box control compatibility with simple commissioning, when ordered with drivers and control options marked by a shaded background¹

To learn more about A+, visit www.acuitybrands.com/aplus.

- 1. See ordering tree for details.
- A+ Certified Solutions for ROAM require the order of one ROAM node per luminaire. Sold Separately: Link to Roam; Link to DTL DLL

Ordering Information

EXAMPLE: DSX1 LED P7 40K T3M MVOLT SPA DDBXD

DSX1LED							
Series	LEDs	Color temperature	Distribution	Voltage	Mounting		
DSX1 LED	Forward optics P1 P4 P7 P2 P5 P8 P3 P6 P9 Rotated optics P10¹ P12¹ P11¹ P13¹	30K 3000 K 40K 4000 K 50K 5000 K AMBPC Amber phosphor converted ²	T1S Type I short T5S Type V short T2S Type II short T5M Type V medium T2M Type II medium T5W Type V wide T3S Type III short BLC Backlight T3M Type III medium control 23 T4M Type IV medium TFTM Forward throw medium T5VS Type V very short T5VS Type V very short	MVOLT 4.5 120 6 208 5.6 240 5.6 277 6 347 5.6.7 480 5.6.7	Shipped included SPA Square pole mounting RPA Round pole mounting WBA Wall bracket SPUMBA Square pole universal mounting adaptor 8 RPUMBA Round pole universal mounting adaptor 8 Shipped separately KMA8 DDBXD U Mast arm mounting bracket adaptor (specify finish) 9		


Control options				Other options		Finish (required)	
PER NEMA PERS Five-v PER7 Seven DMG 0-10V DS Dual s PIR Bi-leve PIRH Bi-leve PIRHN Network	ht AIR generation 2 enabled ¹⁰ IA twist-lock receptacle only (controls ordered separate) 11 -wire receptacle only (controls ordered separate) 11,122 IV dimming extend out back of honsing for external control (leads exit fixture) switching 13,14 vel, motion/ambient sensor, 8–15' mounting height, ambient sensor enabled at 5fc 5,15,16 vork, Bi-Level motion/ambient sensor, 8–15' mounting height, ambient sensor enabled at 1fc 5,15,16 vork, Bi-Level motion/ambient sensor, 8–15' mounting height, ambient sensor enabled at 1fc 5,15,16 vork, Bi-Level motion/ambient sensor, 8–15' mounting height, ambient sensor enabled at 1fc 5,15,16	PIRH1FC3V BL30 BL50 PNMTDD3 PNMT5D3 PNMT6D3 PNMT7D3 FAO	Bi-level, motion/ambient sensor, 15-30' mounting height, ambient sensor enabled at 1fc 5.15.16 Bi-level switched dimming, 30% 5.14.18 Bi-level switched dimming, 50% 5.14.18 Part night, dim till dawn 5.19 Part night, dim 5 hrs 5.19 Part night, dim 6 hrs 5.19 Part night, dim 7 hrs 5.19 Field adjustable output ²⁰	HS SF DF L90 R90	House-side shield ²¹ Single fuse (120, 277, 347V) ⁶ Double fuse (208, 240, 480V) ⁶ Left rotated optics ¹ Right rotated optics ¹ Ded separately Bird spikes ²² External glare shield ²²	DDBXD DBLXD DNAXD DWHXD DDBTXD DBLBXD DNATXD DWHGXD	Dark bronze Black Natural aluminum White Textured dark bronze Textured black Textured natural aluminum Textured white



Part Number: RJ521406 Rev A

Revision Date: 10-6-16

1. Remove the 6 (DSX2) or 4 (DSX0 and DSX1) screws shown from fixture (See Fig 1).

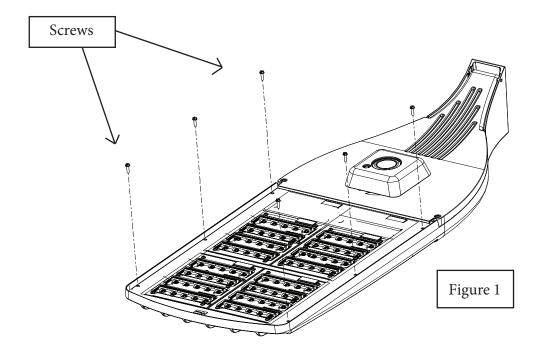

2. Place new EGS shield onto the fixture as shown and attach both the cover and EGS using the same screws that were removed in step one (See Fig 2). Please note that you will be using the four inner holes on the DSX0.

